

WAKA KOTAHI NZ TRANSPORT AGENCY BOMBAY, AUCKLAND WEIGH RIGHT PROGRAMME - BOMBAY CVSC F RAHMAN

LANDSCAPE GENERAL ARRANGEMENT PLAN - WIDER CONTEXT

L-1001

SECURITY FENCE

CONCRETE PAVING

PLANTED TERRAMESH RETAINING WALL AMENITY PLANTING (MAX. 1M HIGH)

EDGE PLANTING (MAX. 1M HIGH) WETLAND EDGE PLANTING

RIPARIAN SCREEN PLANTING

SCREEN UNDERPLANTING

PROPOSED TREE

RIP RAP (REFER TO STORMWATER DRAWINGS)

PERMANENT FARM FENCE

RESOURCE CONSENT 5C4353-WSP-54-DR-

25/01/2024

FR 25/09/2023 FR 19/01/2024 FR 25/01/2024

ISSUED FOR RESOURCE CONSENT
ISSUED FOR RESOURCE CONSENT
ISSUED FOR RESOURCE CONSENT

WAKA KOTAHI NZ TRANSPORT AGENCY

Wellington Office +64 4 471 7000 PO Box 12-003 Wellington 6144 New Zealand

LANDSCAPE ARCHITECTURE

J. FRENCH


M. DRYSDALE

1:500 (A1), 1:1000 (A3)

J. FRENCH

M. DRYSDALE

CADD\01_WIP\LAUD\CADD\5C4353-WSP-54-DR-L-.dwg 1001 Auckland Council | Approved Resource Consent Plan | LUC60424936&LUS60430751 | 13/06/2024 | Page 7 of 17

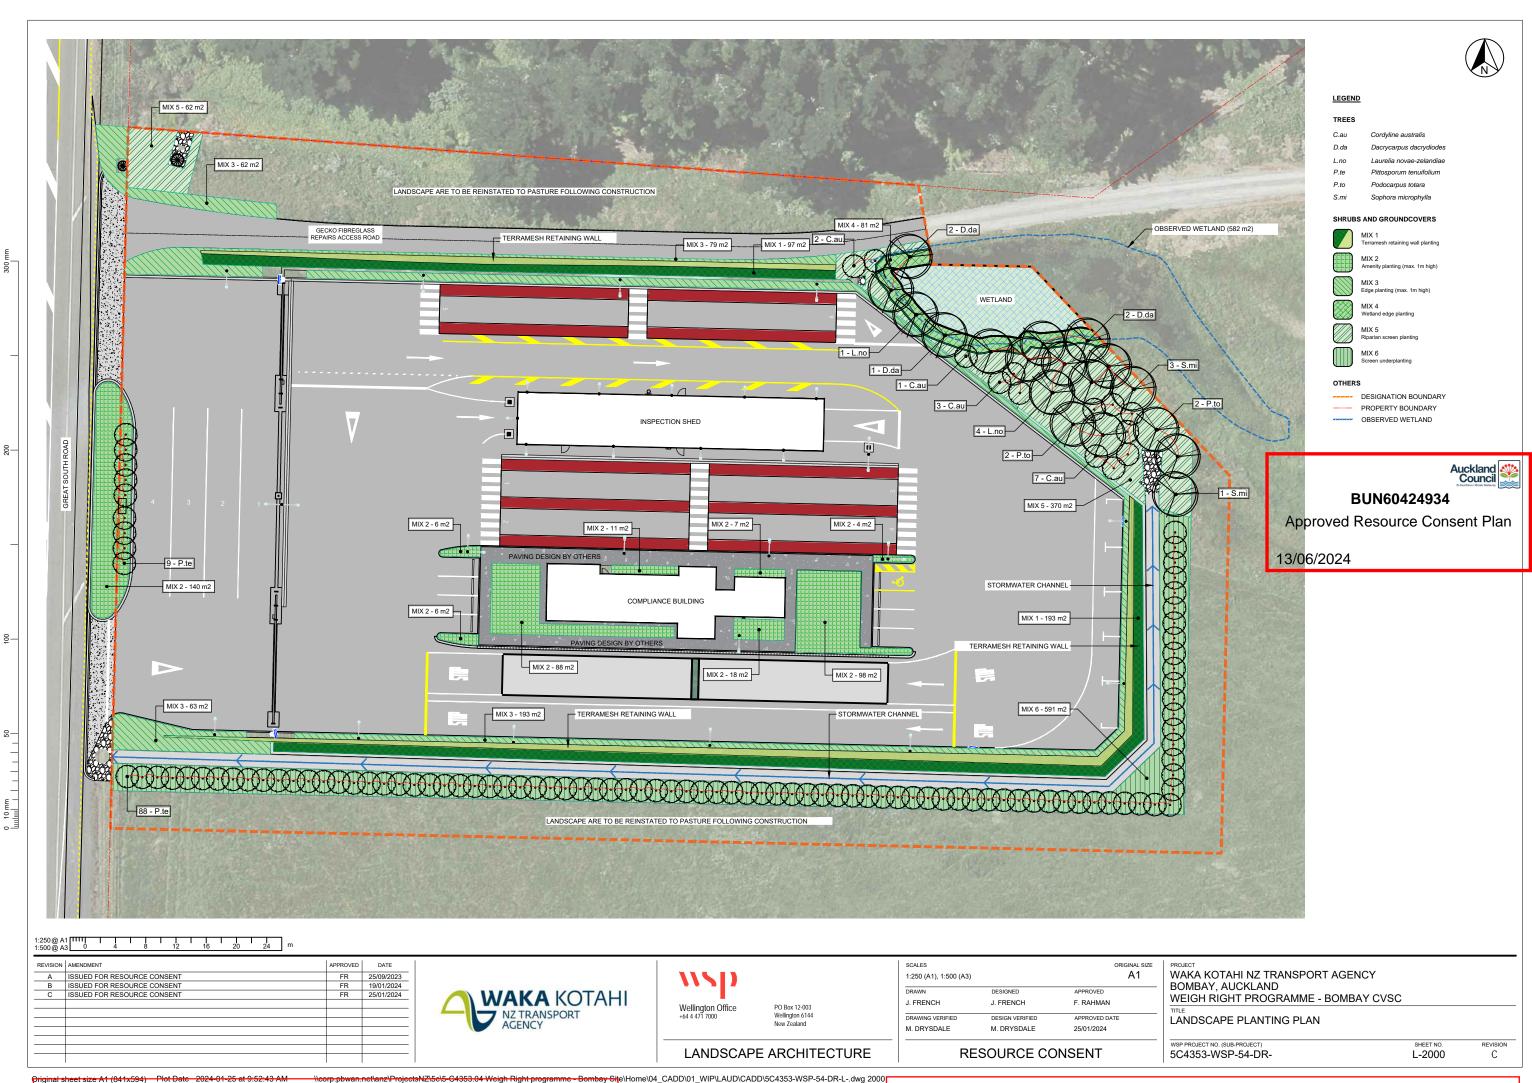

BUN60424934

Approved Resource Consent Plan

13/06/2024

NOTES

GENERAL

- 1. THE LANDSCAPE PLANTING LAYOUT PLAN SHOWS A MASS PLANTING ARRANGEMENT WITHIN THE EXTENT OF WORKS. NOTE THAT HATCHES SHOWN ON THESE DRAWINGS ARE INDICATIVE ONLY AND DO NOT REPRESENT A PLANTING PATTERN.

 2. DRAWINGS SHALL BE READ IN CONJUNCTION WITH THE NZTA P39 STANDARD SPECIFICATION FOR HIGHWAY LANDSCAPE TREATMESTS (THE SPECIFICATION) AND ALL WORKS CARRIED OUT IN ACCORDANCE WITH THE SPECIFICATION.

 3. ALL DIMENSIONS SHOWN IN MM UNLESS OTHERWISE STATED.

 4. DO NOT SCALE OFF THE DRAWINGS, USE DIMENSIONED MEASUREMENTS ONLY.

 5. THE CONTRACTOR SHALL VERIFY ALL DIMENSIONS ON SITE PRIOR TO COMMENCEMENT OF WORK.

 6. THE CONTRACTOR SHALL BE RESPONSIBLE FOR FINAL ON-SITE SETOUT TO ENGINEER APPROVAL.

 7. CONTRACTOR IS TO TAKE ALL CARE TO CONFIRM LOCATION AND DIRECTION OF SERVICES PRIOR TO UNDERTAKING WORKS AND PROTECT THOSE TO BE RETAINED. INSPECT AND DOCUMENT EXISTING SERVICES BEFORE WORK COMMENCES. NOTIFY THE ENGINEER OF ANY DAMAGE.

 8. CONTRACTOR IS RESPONSIBLE FOR INSPECTING AND DOCUMENTING ALL ITEMS TO BE RETAINED, INSCLUDING PRIVATELY OWNED ASSETS PROXIMATE TO THE WORKS, PRIOR TO COMMENCING WORKS.

PLANTING

- 1. ALL PLANTING AREAS TO HAVE A MINIMUM 300MM DEPTH GOOD QUALITY TOPSOIL AS PER THE SPECIFICATION TO FINISHED LEVELS.
 2. ALL PLANTING AREAS TO HAVE MINIMUM 100MM DEPTH MULCH AS PER THE SPECIFICATION.
 3. WHERE POSSIBLE, ALL NATIVE SPECIES TO BE ECO-SOURCED FROM THE LOCAL ECOLOGICAL AREA WITHIN THE AUCKLAND REGIONS.
 4. ALL PLANTS TO BE PLACED IN A QUINCUNX ARRANGEMENT. CONFIRM SETOUT WITH LANDSCAPE ARCHITECT PRIOR TO UNDERTAKING ANY PLANTING WORK.
 5. ALL TREES THAT ARE BEING REMOVED ARE TO BE CONFIRMED BY LANDSCAPE ARCHITECT ONSITE.

PLANT PALETTE

	· · · · · · · · · -						
_	BOTANICAL NAME	COMMON NAME	GRADE (L)	SPACING (m)	PLANT % MIX	QUANTITY	PLACEMENT NOTES
	Trees						
au:	Cordyline australis	Ti kouka/ Cabbage tree	45	as shown	-	13	
.da	Dacrycarpus dacrydiodes	Kahikatea	45	as shown	-	5	Wetland edge planting mix
.no	Laurelia novae-zelandiae	Pukatea	45	as shown	-	5	
.te	Pittosporum tenuifolium	Kohuhu	45	2m / as shown	-	97	Screening
o.to	Podocarpus totara	Totara	45	as shown	-	4	
S.mi	Sophora microphylla	Kowhai	45	as shown	-	4	
	Shrubs and Groundcovers						
	Mix 1 Terramesh Retaining Wall Planting						
	Muehlenbeckia complexa	Pohuehue	1.5	4/m2	100%	1206	Top planting (290 m2)
	Muehlenbeckia complexa	Pohuehue	Root Trainer	1/m2	100%	500	Vertical facing
	Mix 2 (378 m2) Amenity Planting (max. 1m high)						
	Carex testacea	New Zealand Hair Sedge	1.5	4/m2	20%	315	
	Coprosma 'Hawera'	Sand Coprosma	1.5	4/m2	50%	785	
	Libertia peregrinans Phormium cookianum 'Green Dwarf'	Creeping NZ iris Mountain Flax	1.5 1.5	4/m2 1/m2	20% 10%	315 39	Plant min. 2m from path edges
	Mix3 (396 m2) Edge Planting (max. 1m high)						
	Coprosma 'Hawera' Phormium cookianum 'Green Dwarf'	Sand Coprosma Mountain Flax	1.5 1.5	4/m2 1/m2	50% 50%	823 206	
***	Mix 4 (81 m2)						
	Wetland Edge planting						
	Austroderia fulvida	Toetoe	1.5	4/m2	20%	67	Planted away from water
	Carex secta	Purei	1.5	4/m2	20%	67	Planted closer to water
	Carex virgata Cyperus ustulatus	Small swamp sedge Giant umbrella sedge	1.5 1.5	4/m2 4/m2	20% 20%	67 67	
	Juncus edgariae	Wiwi	1.5	4/m2	20%	67	
	Mix 5 (432 m2) Riparian Screen Planting						
	Austroderia fulvida	Toetoe	1.5	4/m2	20%	360	
	Carex virgata	Small swamp sedge	1.5	4/m2	20%	360	
	Coprosma robusta Entelea arborescens	Karamu Whau	1.5 1.5	4/m2 1/m2	20% 10%	360 44	
	Letospermum scoparium	Manuka	1.5	1/m2	20%	90	
	Phormium tenax	Harakeke	5	1/m2	10%	44	
	Mix 6 (591m2)						
	Screen Underplanting						

1:500 @ A3	Ö	4	' 8	12	16	20	24	m

REVISION	AMENDMENT	APPROVED	DATE
Α	ISSUED FOR RESOURCE CONSENT	FR	25/09/2023
В	ISSUED FOR RESOURCE CONSENT	FR	19/01/2024
С	ISSUED FOR RESOURCE CONSENT	FR	25/01/2024



Phormium cookianum 'Green Dwarf'



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SCALES		ORIGINAL SIZE
1:250 (A1), 1:500 (A3)		A1
DRAWN	DESIGNED	APPROVED
J. FRENCH	J. FRENCH	F. RAHMAN
DRAWING VERIFIED	DESIGN VERIFIED	APPROVED DATE
M. DRYSDALE	M. DRYSDALE	25/01/2024

614

100%

_			

PROJECT
WAKA KOTAHI NZ TRANSPORT AGENCY
BOMBAY, AUCKLAND
WEIGH RIGHT PROGRAMME - BOMBAY CVSC
TITLE
LANDSCAPE PLANT SCHEDULE AND NOTES

RESOURCE CONSENT

WSP PROJECT NO. (SUB-PROJECT)	SHEET NO.
5C4353-WSP-54-DR-	L-3000

С

LANDSCAPE ARCHITECTURE




REVISION

L-4000

BUN60424934


Approved Resource Consent Plan

13/06/2024

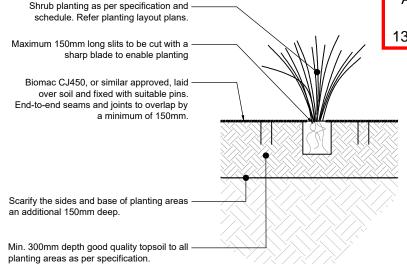


TYPICAL SHRUB PLANTING (GEOFABRIC) - MIX 3, MIX 4 & MIX 5

Scale: 1:10 (A1) 1:20 (A3)

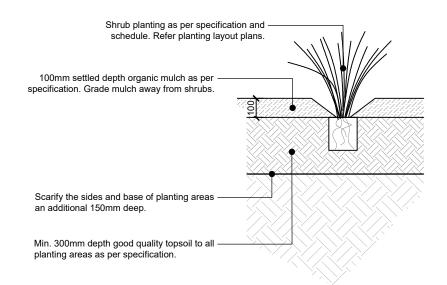

TYPICAL SHRUB PLANTING (MULCH) - MIX 1, MIX 2 & MIX 6

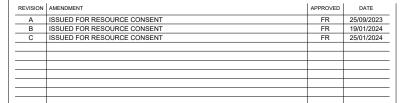

750

01 TYPICAL 45L TREE PLANTING



2400mm long x 90mm H4 timber stakes driven into firm ground, stakes to be vertical and of matching height. Allow 3no. stakes for

50mm hessian webbing firmly fixed with galvanised staples to stakes at 2/3 the height

Minimum 100mm settled depth cushion fall as mulch. Grade mulch away from plant and

Existing topsoil and subgrade retained. Trim or backfill to achieve required levels

Tree pit 2x the diamater and 1.5x the depth of rootball. Backfill with good quality tree planting medium as per specification in evenly consolidated 150mm layers (not compacted)

Scarify the sides and base of tree pit an

100mm depth approved 20/7 drainage metal.

45L trees.

of the main trunk.

additional 150mm.

tree stems.



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LANDSCAPE ARCHITECTURE

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	ORIGINAL SIZE A1
DESIGNED	APPROVED
J. FRENCH	F. RAHMAN
DESIGN VERIFIED	APPROVED DATE
M. DRYSDALE	25/01/2024
	J. FRENCH DESIGN VERIFIED


LANDSCAPE TYPICAL PLANTING DETAILS

WAKA KOTAHI NZ TRANSPORT AGENCY

WEIGH RIGHT PROGRAMME - BOMBAY CVSC

WSP PROJECT NO. (SUB-PROJECT)
5C4353-WSP-54-DR-


BOMBAY, AUCKLAND

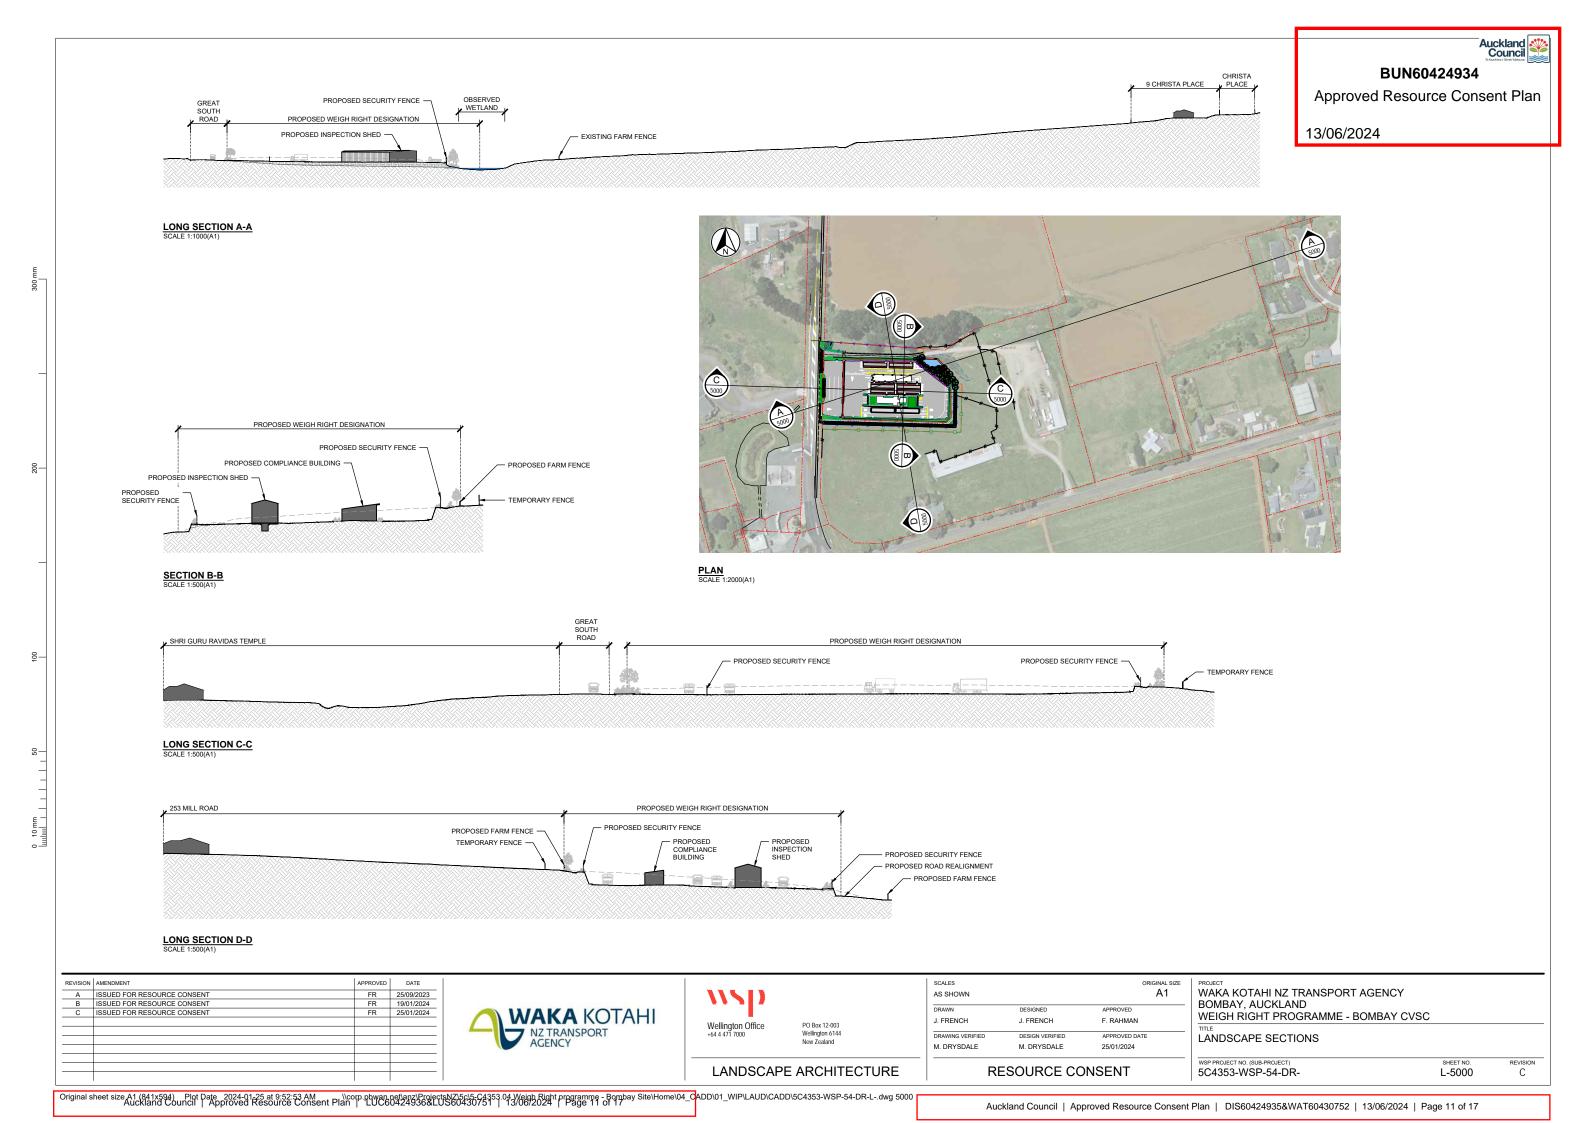

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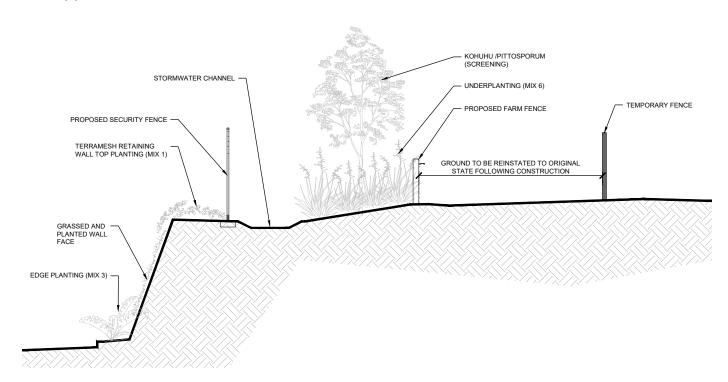
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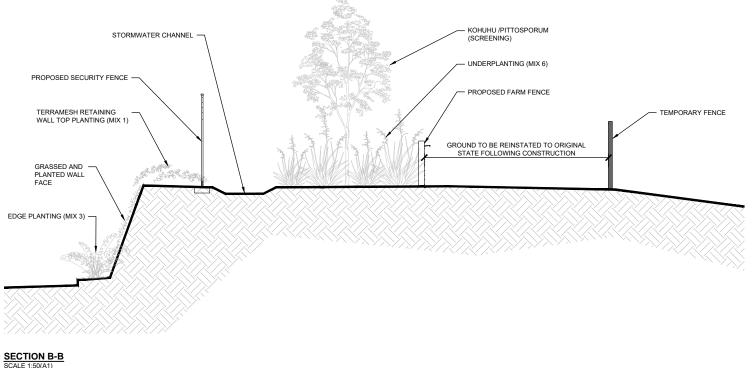
13/06/2024



PLAN SCALE 1:2000(A1)

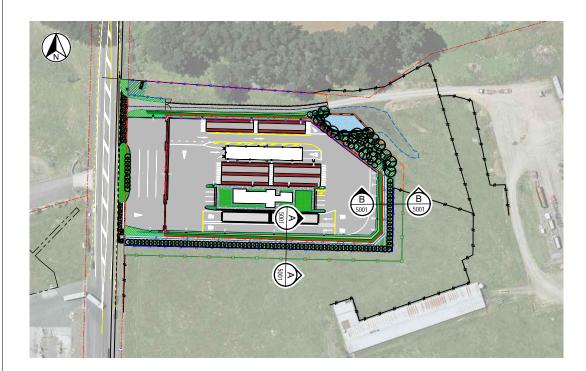SECTION A-A SCALE 1:50(A1)





ORIGINAL SIZE

REVISION	AMENDMENT	APPROVED	DATE
A	ISSUED FOR RESOURCE CONSENT	FR	19/01/2024
В	ISSUED FOR RESOURCE CONSENT	FR	25/01/2024

WAKA KOTAHI
WAKA KOTAHI NZ TRANSPORT AGENCY
AGENCY

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LANDSCAPE ARCHITECTURE

SCALES

AS SHOWN

 DRAWN
 DESIGNED
 APPROVED

 A. LIANG
 J. FRENCH
 F. RAHMAN

 DRAWING VERIFIED
 DESIGN VERIFIED
 APPROVED DATE


 M. DRYSDALE
 M. DRYSDALE
 25/01/2024

RESOURCE CONSENT

WAKA KOTAHI NZ TRANSPORT AGENCY
BOMBAY, AUCKLAND
WEIGH RIGHT PROGRAMME - BOMBAY CVSC

TITLE
LANDSCAPE SECTIONS

WSP PROJECT NO. (SUB-PROJECT)
SHEET NO. REVISION
5C4353-WSP-54-DRL-5001
B

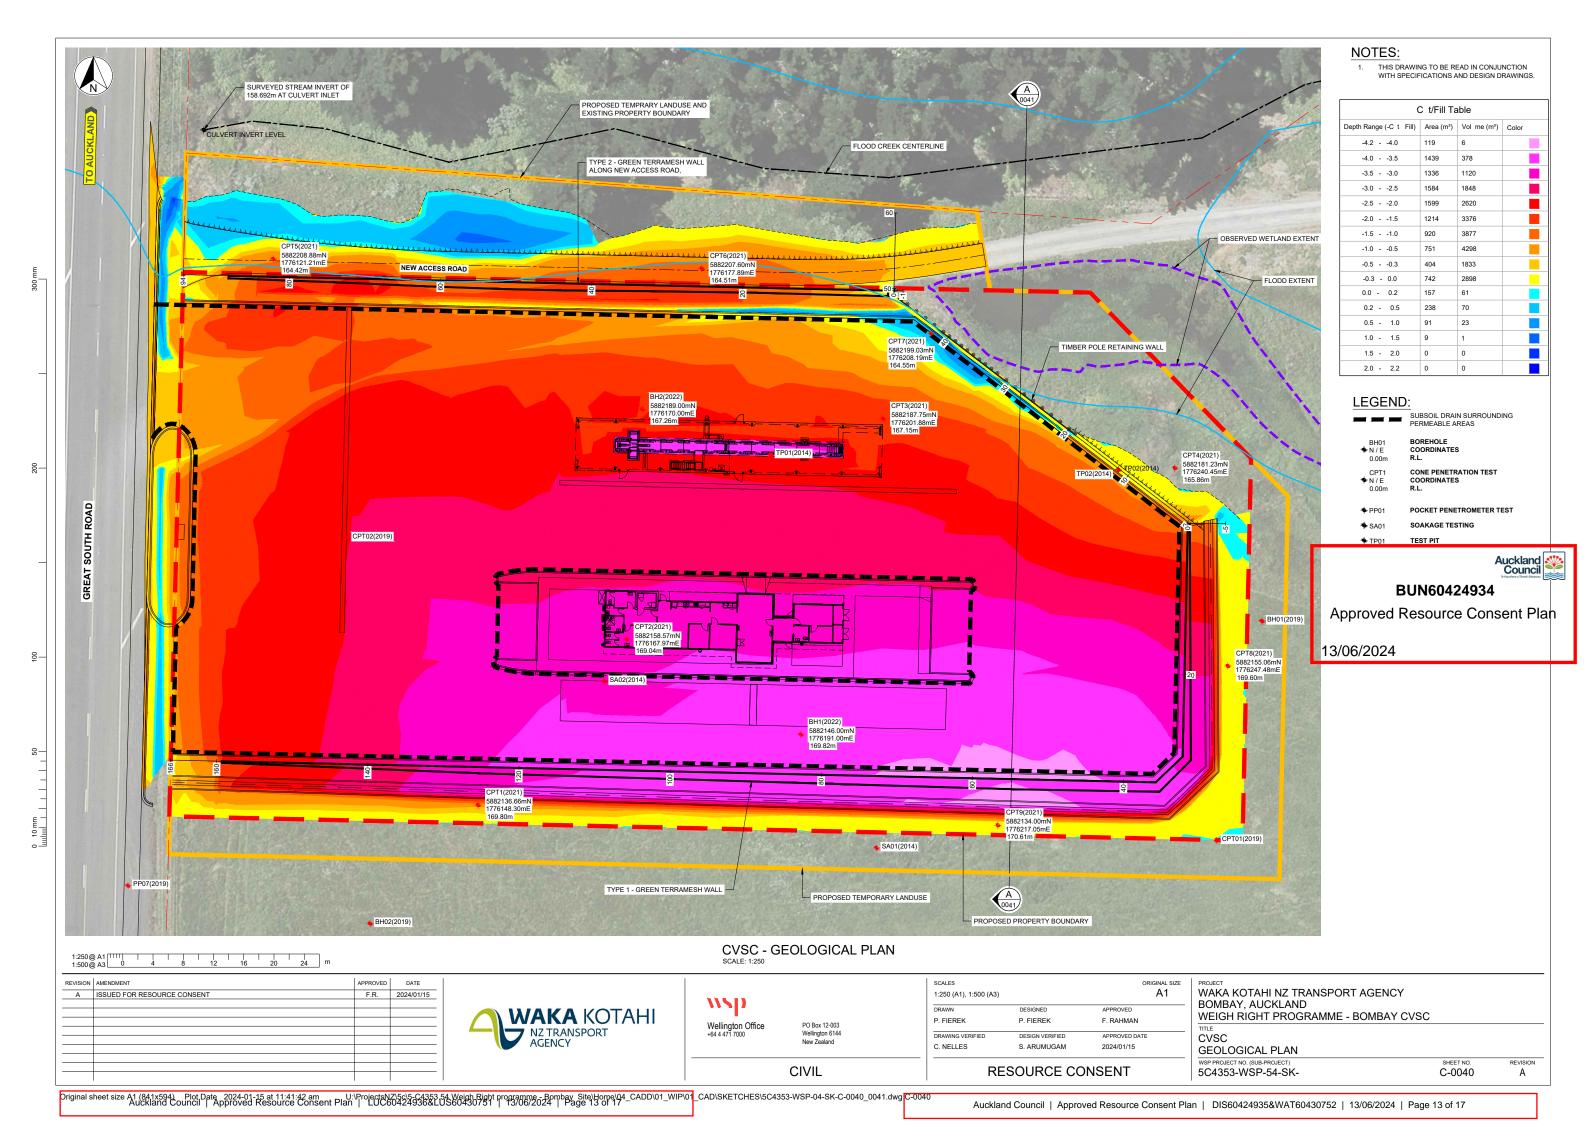

NOTES:


THIS DRAWING TO BE READ IN CONJUNCTION WITH SPECIFICATIONS AND DESIGN DRAWINGS.

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13/06/2024



APPROVED DATE F.R. 2024/01/15 F.R. 2024-03-08

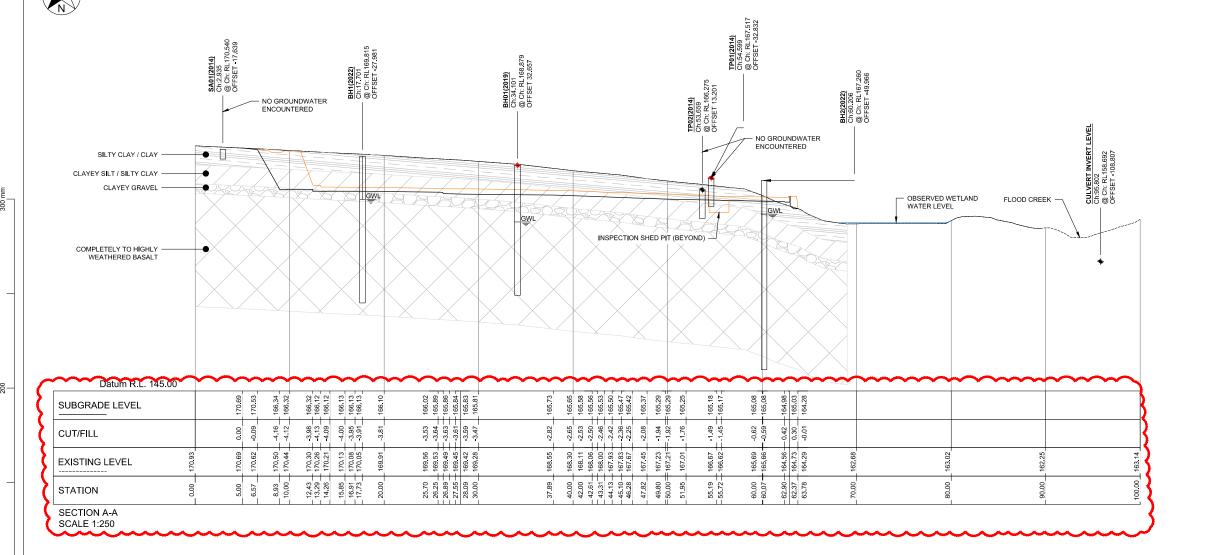

//SD Wellington Office

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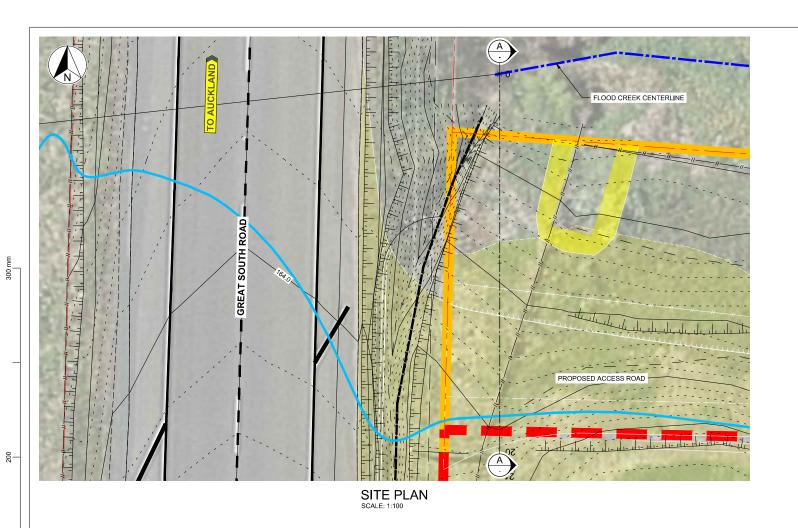
CIVIL


ORIGINAL SIZE 1:200 (A1), 1:400 (A3) P. FIEREK P. FIEREK F. RAHMAN C. NELLES S. ARUMUGAM 2024-03-08

RESOURCE CONSENT


WAKA KOTAHI NZ TRANSPORT AGENCY BOMBAY, AUCKLAND WEIGH RIGHT PROGRAMME - BOMBAY CVSC GEOLOGICAL SECTION A-A REVISION B SHEET NO. C-0041 5C4353-WSP-54-SK-

SCALES



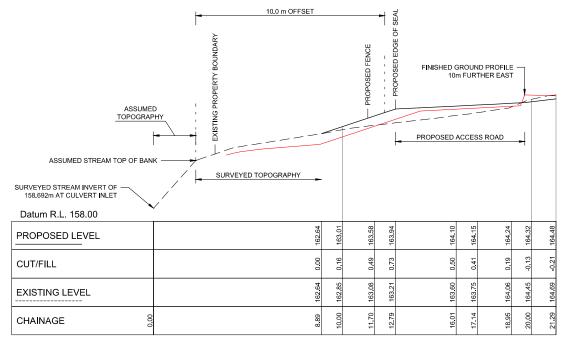

SECTION A-A

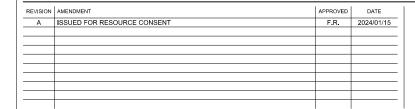





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CIVIL

SCALES

 1:100 (A1), 1:200 (A3)
 A1

 DRAWN
 DESIGNED
 APPROVED

 P. FIEREK
 P. FIEREK
 F. RAHMAN

 DRAWING VERIFIED
 DESIGN VERIFIED
 APPROVED DATE

 C. NELLES
 T. KALMAR
 2024-01-15

RESOURCE CONSENT

WAKA KOTAHI NZ TRANSPORT AGENCY
BOMBAY, AUCKLAND
WEIGH RIGHT PROGRAMME - BOMBAY CVSC

TITLE
CVSC
SITE PLAN AND SECTION A-A

WSP PROJECT NO. (SUB-PROJECT)
SC4353-WSP-54-DRC-0030
A

NOTES:

LEGEND:

BUN60424934Approved Resource Consent Plan

13/06/2024


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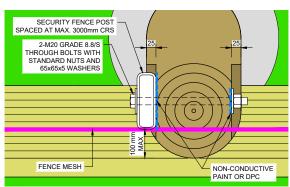
Auckland Council

— - - EXISTING PROPERTY BOUNDARY

Original sheet size A1 (841x594) Plot Date 2024-01-15 at 11:34:50 am U:\ProjectsNZ\5c\5c\5c\4353.54 Weigh Right programme - Bombay Site\Home\04_CADD\01_WIP\01_CAD\SKETCHES\5C4353-WSP-04-SK-C-0030.dwg C-0030 Auckland Council | Approved Resource Consent Plan | LUC60424936&LUS60430751 | 13/06/2024 | Page 15 of 17

Auckland Council | Approved Resource Consent Plan | DIS60424935&WAT60430752 | 13/06/2024 | Page 15 of 17



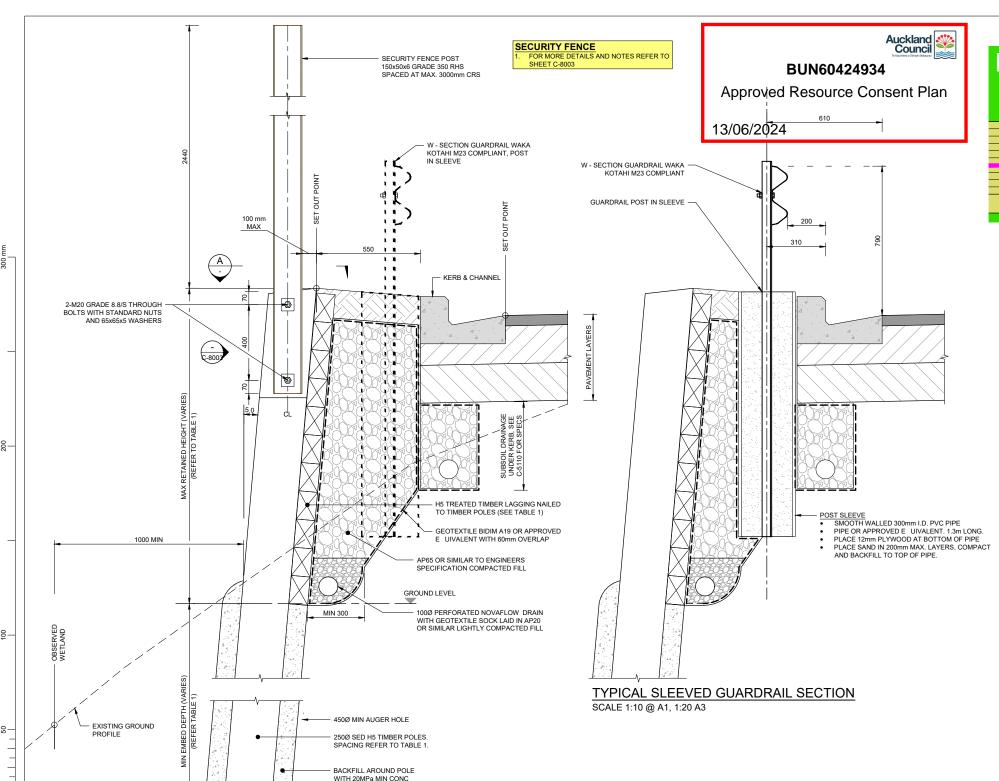




TIMBER RETAINING WALL NOTES

- ALL DIMENSIONS IN mm UNLESS OTHERWISE SPECIFIED.
 ALL DWGS TO BE READ IN CONJUNCTION WITH THE

 - 2. ALL DWGS TO BE READ IN CONJUNCTION WITH THE WSP GEOTECHNICAL SPECIFICATION.
 3. FOR GENERAL ARRANGEMENTS OF WORKS SHOWN ON THIS DWG, REFER TO CIVIL DWGS.
 4. EXISTING SERVICES NOT SHOWN. VERIFY LOCATION OF ALL EXISTING SERVICES ON SITE BEFORE COMMENCING ANY WORKS.
 5. CONTRACTOR SHALL SET OUT THE PILE LOCATIONS & THESE MUST BE AGREED TO BY THE ENGINEER PRIOR TO INSTALL ALTON.
 - & THESE MUST BE AGREED TO BY THE ENGINEER
 PRIOR TO INSTALLATION.
 SHOULD ANY CHANGES TO THE PILE SPACING BE
 RE UIRED BECAUSE OF SERVICES, PRIOR
 APPROVAL MUST BE OBTAINED FROM THE
 ENGINEER.
 TIMBER LAGGING SHOULD BE MADE TO FIT AROUND
 THE SERVICES AS NECESSARY.

 - THE SERVICES AS NECESSARY.
 TIMBER TREATMENT SHALL USE CCA (COPPER
 - 6. TIMBER TREATMENT SHALL USE CCA (COPPER CHROME ARSENIC) PRESERVATIVE.
 7. WHERE STEEL IS IN CONTACT WITH TREATED TIMBER A NON-CONDUCTIVE PAINT SYSTEM SHALL BE APPLIED, OR ALTERNATIVELY A DAMP PROOF COURSE (DPC) SHALL BE PLACED BETWEEN THE STEEL AND TIMBER.
 8. ALL TIMBER TREATMENTS TO BE AS SPECIFIED IN NZS 3602:2003.

 - 9. FENCE FIXINGS IN CONTACT WITH TIMBER TO BE STAINLESS STEEL GRADE 316. APPROVED ISOLATION KITS TO BE PROVIDED BETWEEN STAINLESS STEEL FIXINGS AND HDG ELEMENTS.

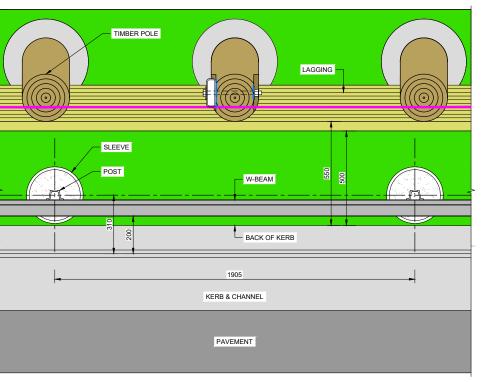

GUARDRAIL SET-OUT PLAN SCALE 1:10 @ A1, 1:20 A3

TABLE 1 - TIMBER POLE & LAGGING SCHEDULE						
WALL TYPE	MAXIMUM RETAINED HEIGHT (m)	POLE SPACING (m)	MIN EMBED DEPTH (m)	LAGGING DIMENSIONS (mm)		
TYPE 1 (TIMBER)	< 1.50	1.5 CRS	5.0	100 x 150		
TYPE 2 (TIMBER)	1.50 - 2.20	1.0 CRS	3.0	100 X 130		

REVISION AMENDMENT APPROVED DATE 0A ISSUED FOR TENDER F.R. 2023-11-13



Hamilton Office +64 7 838 9344 Private Bag 3057 Waikato Mail Centre Hamilton 3240

CIVIL

SCALES A1 1:10, 20 (A1), 1:20, 40 (A3) DRAWN C ESPINOSA S GARRIEI F RAHMAN DRAWING VERIFIE C. NELLES S. ARUMUGAM 2023-11-13

TENDER

WAKA KOTAHI NZ TRANSPORT AGENCY BOMBAY, AUCKLAND WEIGH RIGHT PROGRAMME - BOMBAY CVSC RETAINING WALL DETAILS - SHEET 1 OF 2 TIMBER POLE

REVISION 0A

C-3010

50mm CONC SPACER

TYPICAL CROSS SECTION - TIMBER RETAINING WALL

5C4353-WSP-54-DR-

